



- GENERAL NOTES
1. ALL DIMENSIONS ARE IN MILLIMETRES UNLESS NOTED OTHERWISE
  2. ONLY WRITTEN DIMENSIONS SHALL BE USED. NO DIMENSIONS SHALL BE SCALED FROM THE DRAWINGS
  3. ALL LEVELS ARE IN METRES AND ARE TO MALIN HEAD DATUM
  4. ALL COORDINATES ARE IN METRES AND ARE TO IRISH TRANSVERSE MERCATOR
  5. DRAWINGS ARE TO BE READ IN CONJUNCTION WITH THE SPECIFICATION
  6. THIS DRAWING IS TO BE USED ONLY FOR THE PURPOSES OF THE PLANNING APPLICATION AND IS SUBJECT TO DETAILED DESIGN

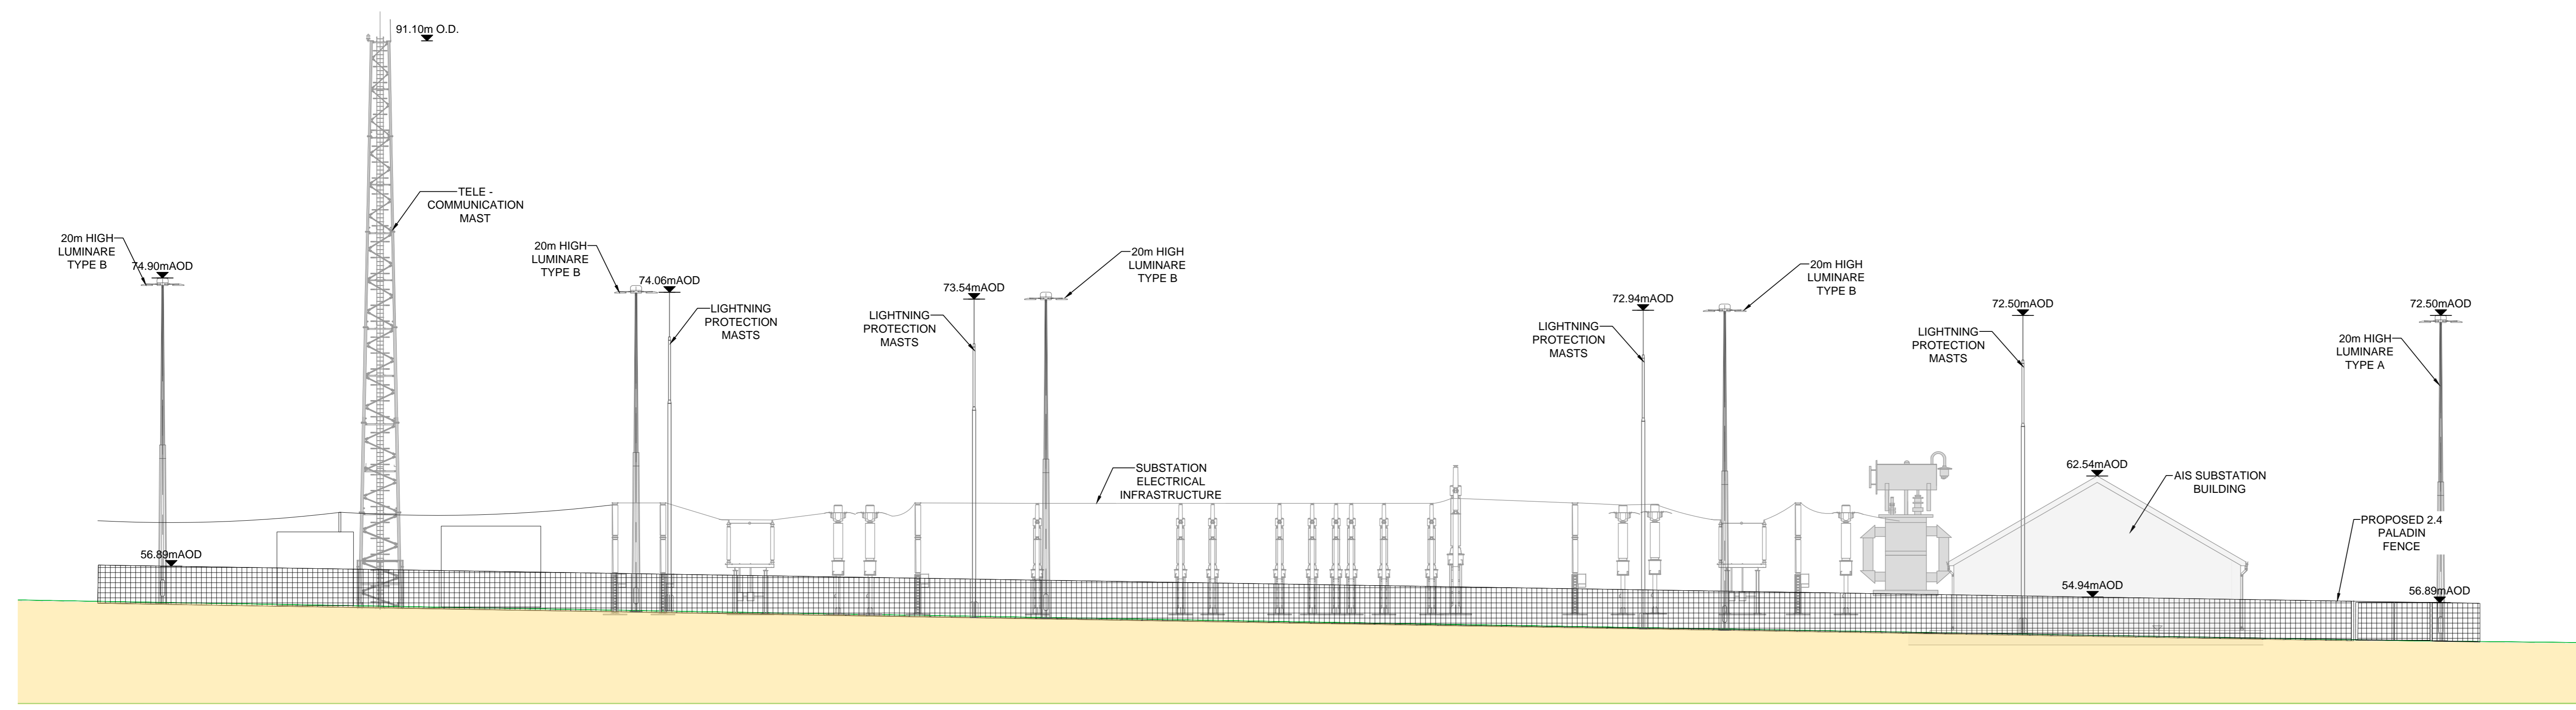

3 AIS Substation Compound - South West Elevation  
SCALE 1:200

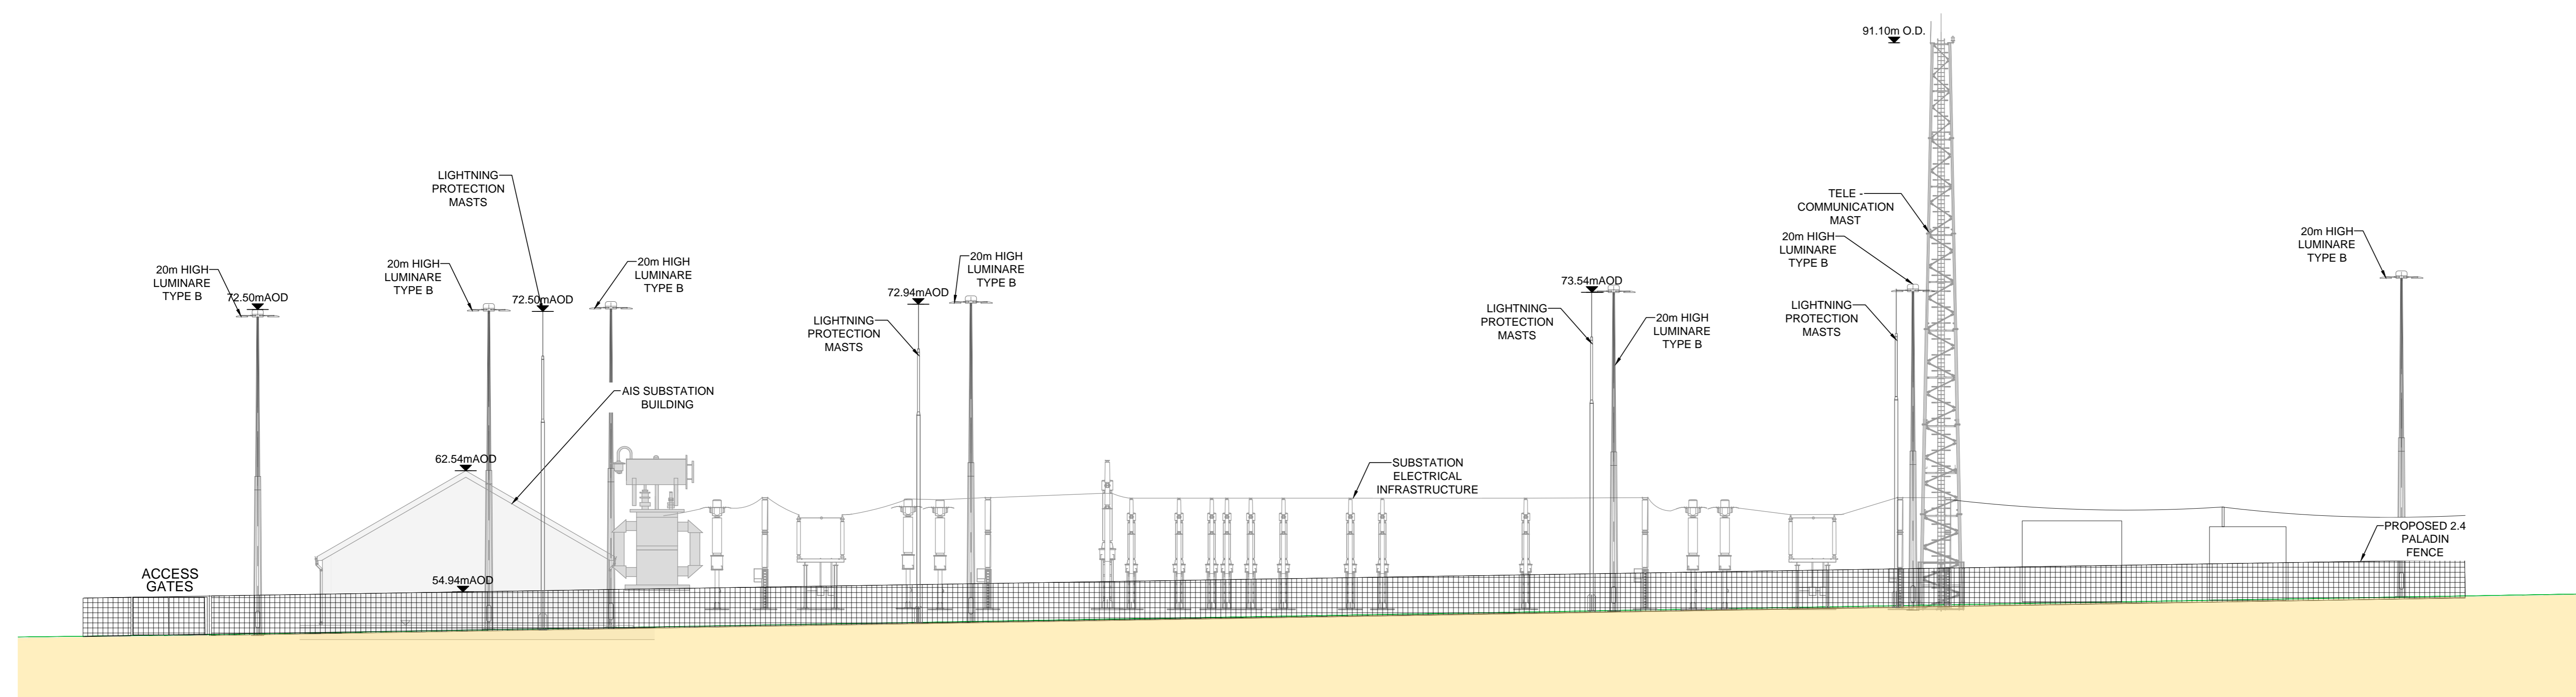

4 AIS Substation Compound -North East Elevation  
SCALE 1:200

P:\EIS\Project-Sub\011483\B\_Nep-Drawings\A1\_AutoCad\FPS-A1R-Z1-02-000002\FPS-A1R-Z1-02-000002.dwg

Rev	Description	By	Date	Chk'd	Auth
0	ISSUED FOR PLANNING	PS	13.03.26	ND	AJB

**AtkinsRéalis**  
DUBLIN | CORK | GALWAY | DUNDALK  
ATKINS HOUSE, 150 AIRSIDE BUSINESS PARK,  
SWORDS, DUBLIN, K67 K5W4.  
Tel: +353 1 810 8000 Email: info.ie@atkinsrealis.com

**Bord Gáis Energy**  
Project: CASHLA PEAKER PLANT 220KV  
SUBSTATION AND GRID CONNECTION  
Rathmorrisry, Pollinagroagh, Moanbaun, Castletambert,  
Knocknacreeva, Caranduff, Caherbriskau, Lisheenkyle  
East, Barrettspark, CASHLA, Athenry, Co. Galway.

Purpose		PLANNING			
Title		SUB STATION ELEVATIONS SHEET 02			
Original Scale	Design/Drawn	Checked	ND	Authorised	AJB
1:200 at A0	PS	PS	13.03.26	13.03.26	13.03.26
Sheet	Drawing Number	Rev			
A2	PEK3-ATK-ZZ-02-DR-CE-900075	0			